CITY OF MILTON, WISCONSIN

2016 PAVEMENT IMPROVEMENTS




SHEET INDEX

SHEET NO.

4-8 9-10 11 11

12

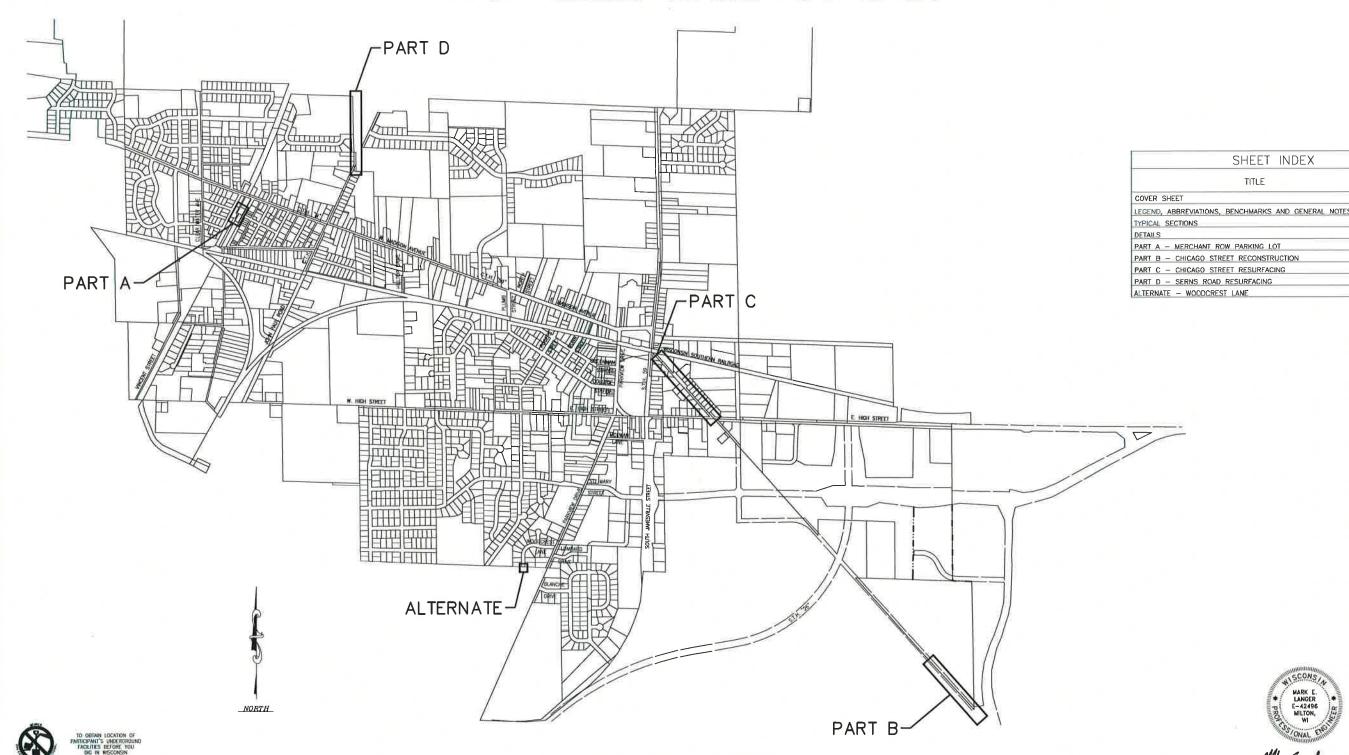






BAXTER & WOODMAN, INC. STATE OF WISCONSIN - PROFESSIONAL DESIGN FIRM LICENSE NO. - 484-011 - EXPIRES 1/31/2018

1-800-242-8511

PROJECT NO.: 160530 DATE: 6/24/16



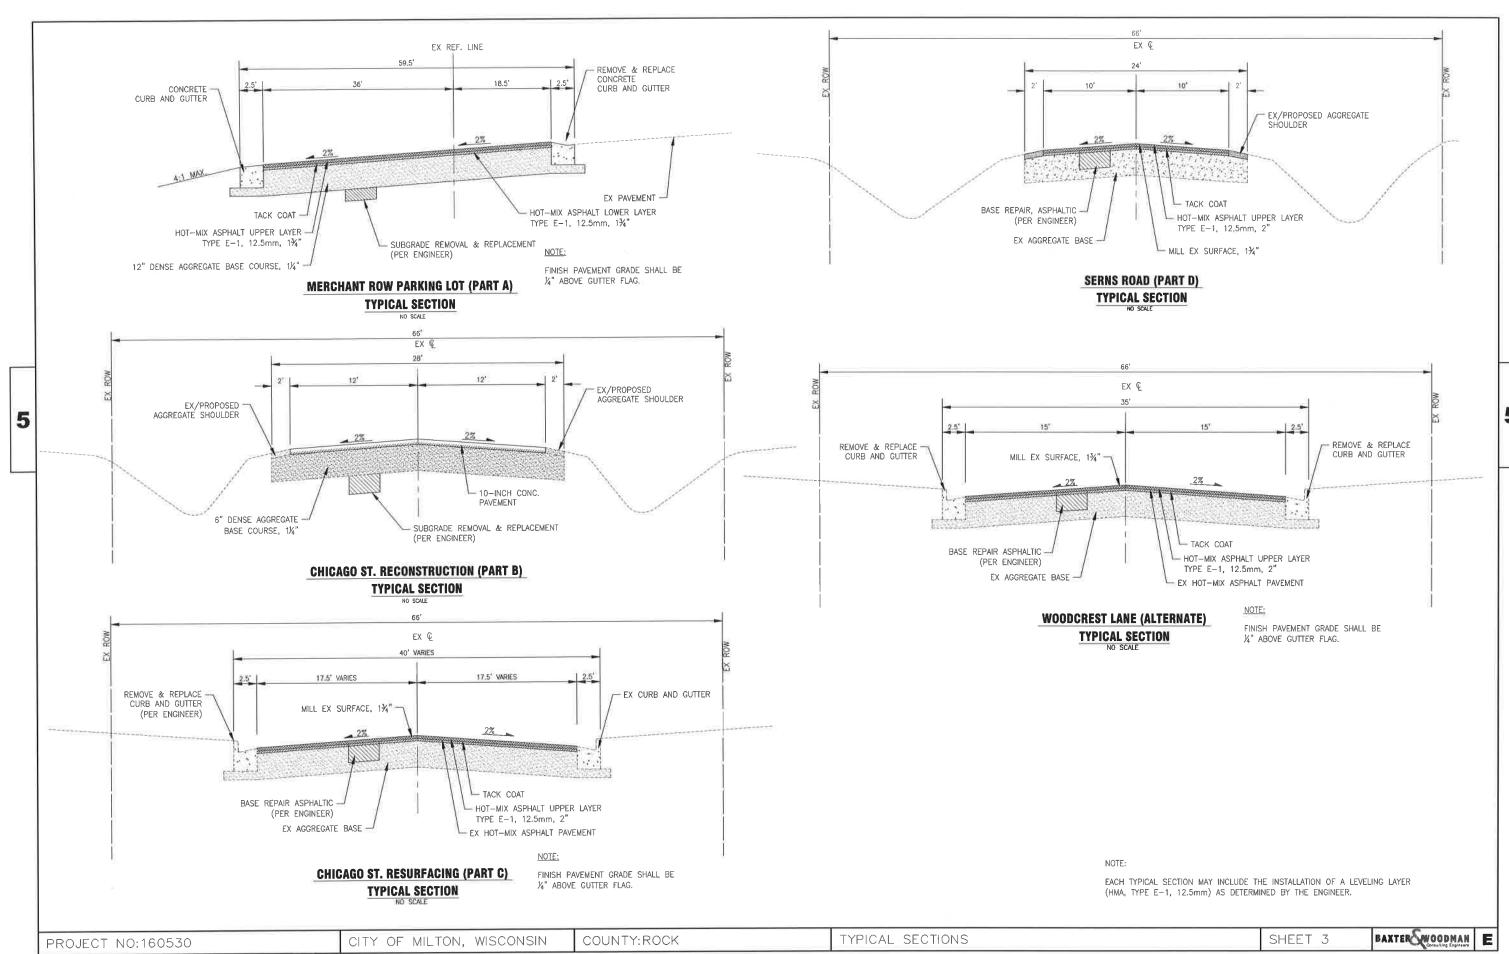

FILE NAME : I:\BURLINGTON\MILTC\160530-MILTC - 2016 PAVEMENT IMP\CADD\DRAWINGS\DWG\40 - CURRENT\160530-GLD_DWG LAYOUT NAME - 160530-GLD - TYP1


PLOT DATE : 6/28/2016 8:04 AM

PLOT BY : TIMOTHY L. BREY


PLOT SCALE: AS NOTED

WISDOT/CADDS SHEET 44



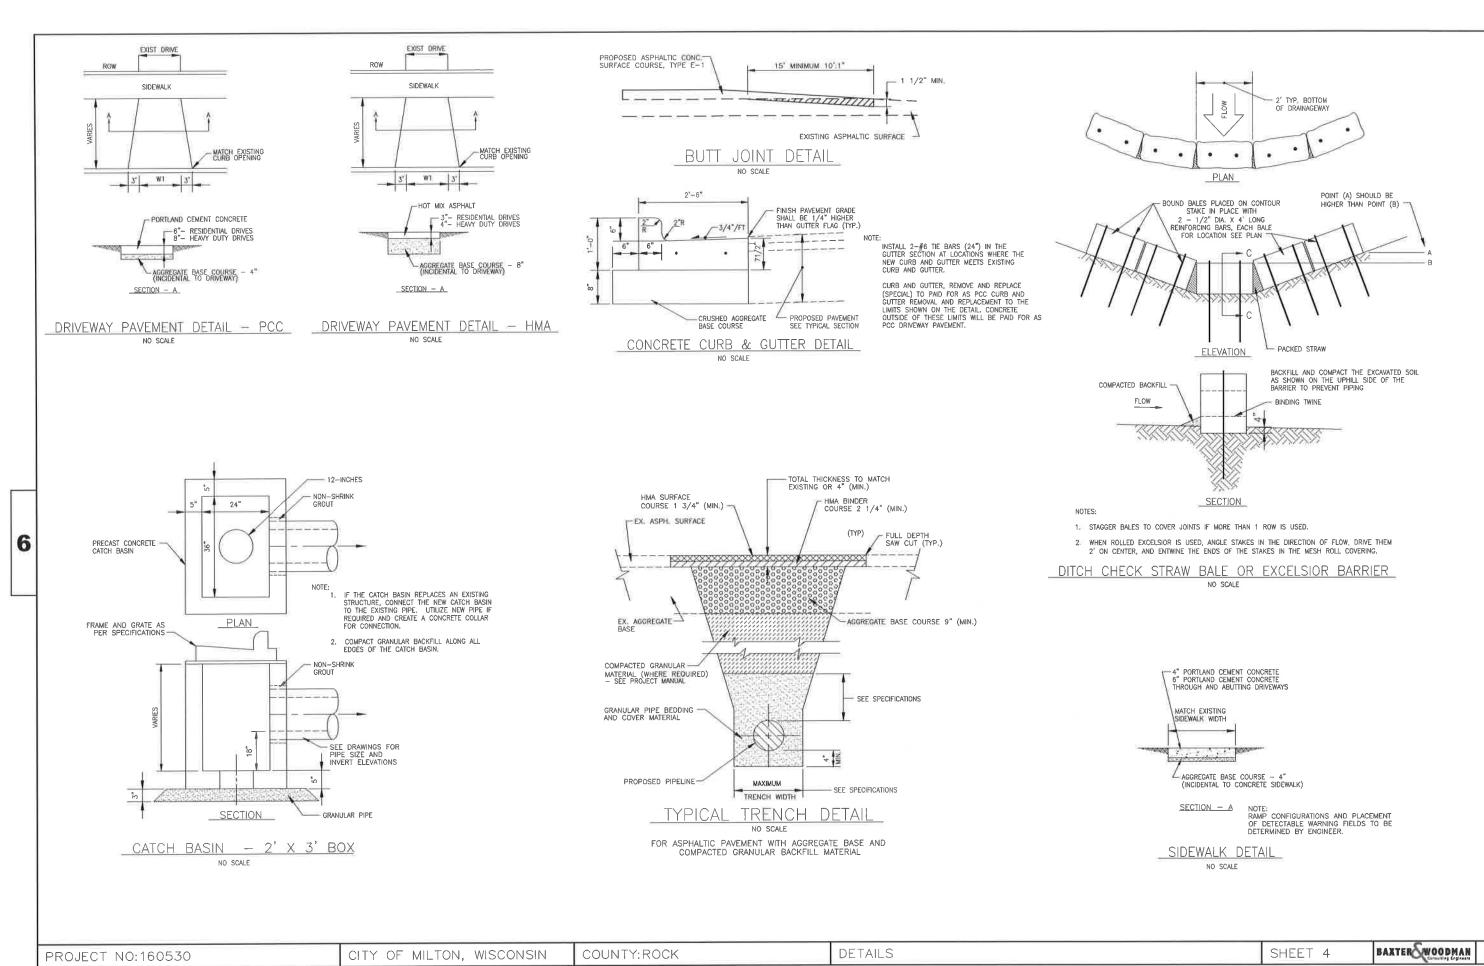



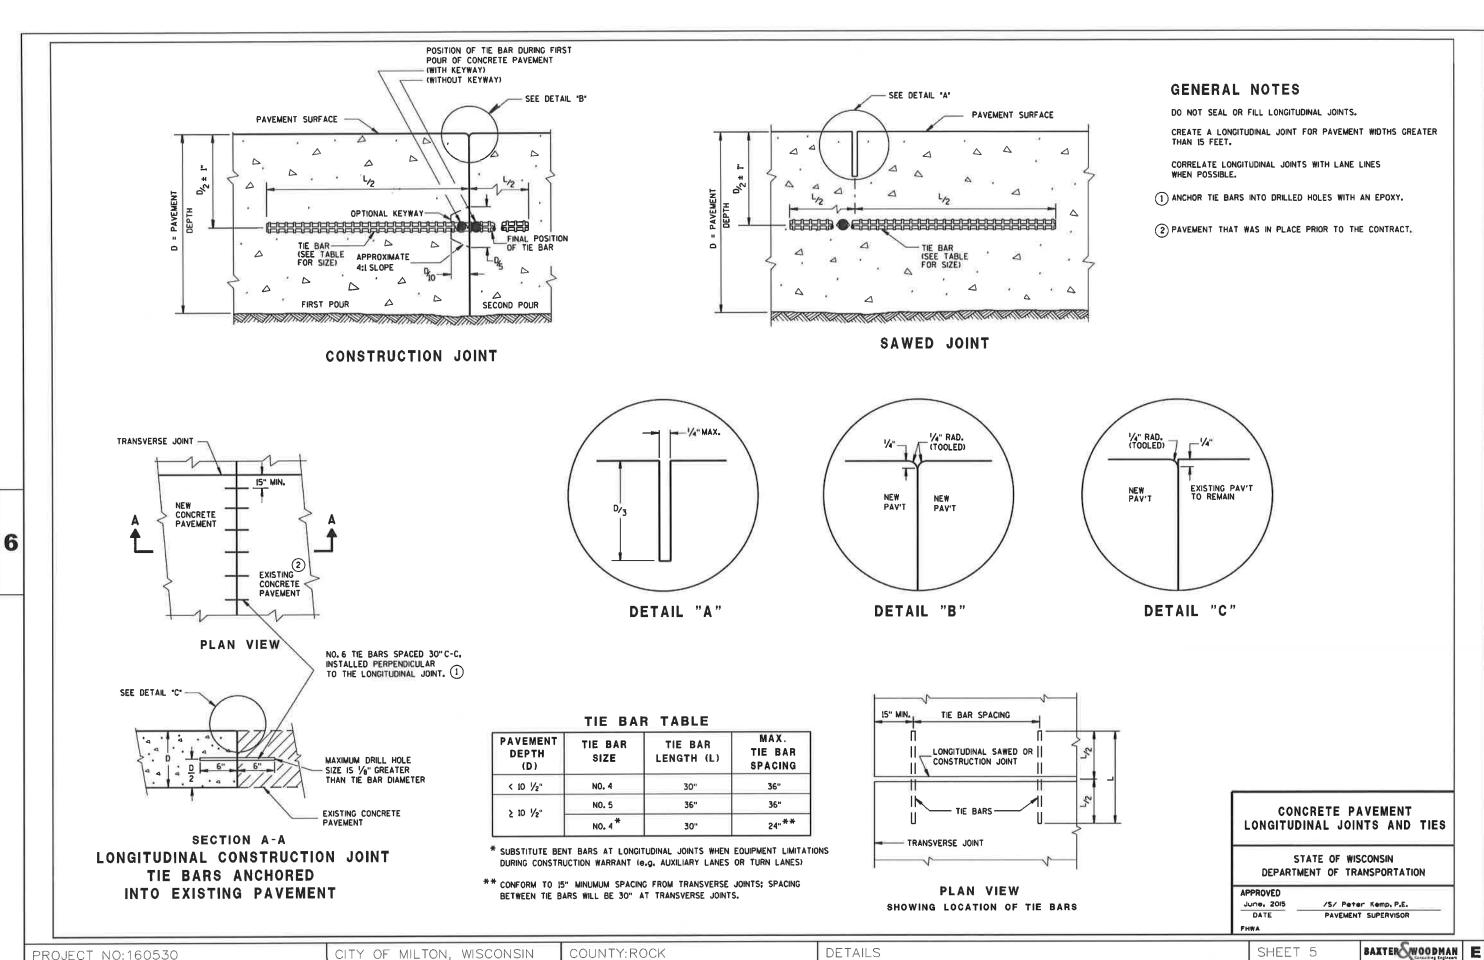



CONTRACTION JOINTS

GENERAL NOTES

CONSTRUCT TRANSVERSE CONTRACTION JOINTS NORMAL TO THE CENTERLINE. SHOW THE LOCATION OF CONTRACTION JOINTS THROUGH INTERSECTIONS ON THE PLANS OR AS DIRECTED BY THE ENGINEER.

DO NOT SEAL OR FILL CONTRACTION JOINTS.

INSTALL DOWEL BARS PARALLEL TO THE PAVEMENT CENTERLINE AND PAVEMENT SURFACE.

FOR PAVEMENT SLABS OF VARYING WIDTHS, LOCATE THE OUTER MOST DOWEL BAR SO THAT THE CENTER OF THE BAR IS A MINIMUM OF 6 INCHES AND A MAXIMUM OF 18 INCHES FROM THE FREE EDGE OF PAVEMENT.

CONSTRUCTION JOINTS


LOCATE CONSTRUCTION JOINTS A MINIMUM OF 6 FEET FROM THE NEAREST CONTRACTION JOINT AND ALIGN PARALLEL TO CONTRACTION JOINTS.


- 1 REFER TO TYPICAL CROSS SECTIONS FOR ADDITIONAL DETAILS.
- (2) MEASURE THE ENTIRE PAVED WIDTH INCLUDING THE PORTION(S) LABELED PAVED SHOULDER AS CONCRETE PAVEMENT.

PAVEMENT DEPTH. DOWEL BAR SIZE AND JOINT SPACING TABLE


PAVEMENT DEPTH (D)	DOWEL BAR DIAMETER	CONTRACTION JOINT SPACING
5 1/2", 6",6 1/2"	NONE	12'
7".7 1/2"	t"	14'
8".8 1/2"	11/4"	15'
9".9 1/2"	11/4"	15'
IO" & ABOVE	1 1/2"	15'


TRAVELED WAY 30'-0" PAVED WIDTH 24'-0" TRAVELED WAY _PAVED SHOULDER PAVED LONGITUDINAL SHOULDER JOINT SECTION A-A TWO-LANE TWO-WAY HIGHWAY

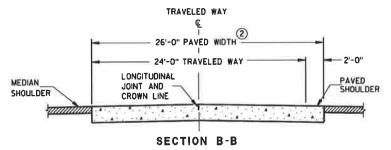

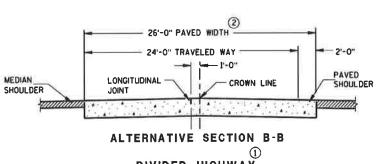

DIVIDED HIGHWAY

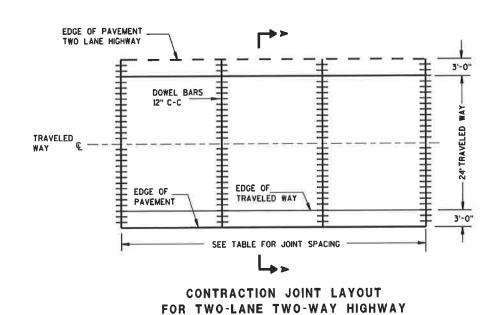

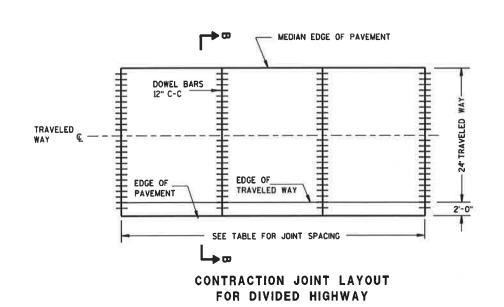

RURAL DOWELED CONCRETE PAVEMENT

STATE OF WISCONSIN DEPARTMENT OF TRANSPORTATION

PROJECT NO:160530

CITY OF MILTON, WISCONSIN

COUNTY: ROCK


PLOT DATE : 6/28/2016 8:04 AM

DETAILS

PLOT BY : TIMOTHY L. BREY

BAXTER WOODMAN



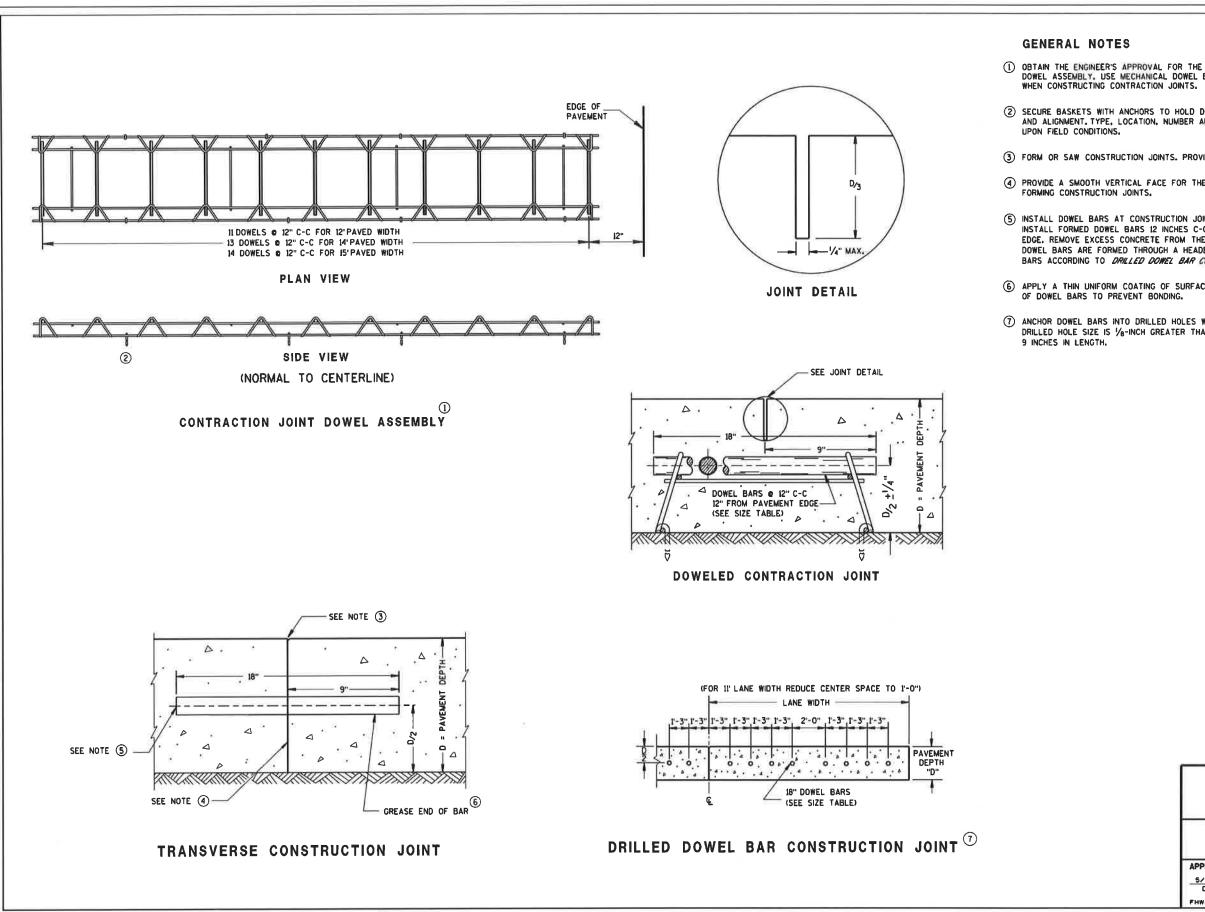

(1) OBTAIN THE ENGINEER'S APPROVAL FOR THE USE OF ALTERNATIVE DESIGNS OF THE DOWEL ASSEMBLY. USE MECHANICAL DOWEL BAR INSERTERS OR DOWEL ASSEMBLIES

2 SECURE BASKETS WITH ANCHORS TO HOLD DOWEL BARS IN THE CORRECT POSITION AND ALIGNMENT. TYPE, LOCATION, NUMBER AND LENGTH OF ANCHORS ARE DEPENDENT

3 FORM OR SAW CONSTRUCTION JOINTS. PROVIDE A 1/4-INCH RADIUS AT FORMED JOINTS.

4 PROVIDE A SMOOTH VERTICAL FACE FOR THE ENTIRE DEPTH OF THE PAVEMENT WHEN FORMING CONSTRUCTION JOINTS.

(5) INSTALL DOWEL BARS AT CONSTRUCTION JOINTS BY FORMING OR DRILLING. INSTALL FORMED DOWEL BARS 12 INCHES C-C AND 12 INCHES FROM PAVEMENT EDGE. REMOVE EXCESS CONCRETE FROM THE FREE END OF THE DOWEL BAR IF DOWEL BARS ARE FORMED THROUGH A HEADER BOARD. INSTALL DRILLED DOWEL BARS ACCORDING TO DRILLED DOWEL BAR CONSTRUCTION JOHNT DETAIL.

6 APPLY A THIN UNIFORM COATING OF SURFACE TREATMENT TO THE FREE END

7 ANCHOR DOWEL BARS INTO DRILLED HOLES WITH AN EPOXY. MAXIMUM DRILLED HOLE SIZE IS 1/8-INCH GREATER THAN DOWEL BAR DIAMETER.

> RURAL DOWELED CONCRETE PAVEMENT

STATE OF WISCONSIN DEPARTMENT OF TRANSPORTATION

APPROVED

5/3/2013 DATE /S/ Deb Bischoff
PAVEMENT POLICY & DESIGN ENGINEER

CITY OF MILTON, WISCONSIN PROJECT NO:160530


COUNTY: ROCK PLOT DATE : 6/28/2016 8:04 AM


DETAILS

PLOT BY : TIMOTHY L. BREY

SHEET 7

BAXTER WOODMAN E

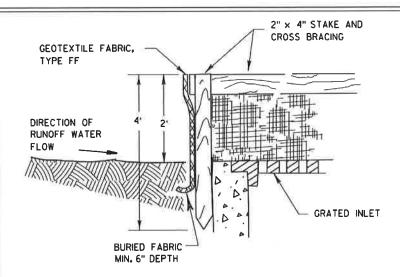

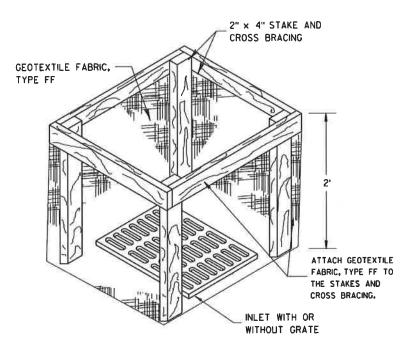

INLET PROTECTION, TYPE A


GENERAL NOTES

INLET PROTECTION DEVICES SHALL BE MAINTAINED OR REPLACED AT THE DIRECTION OF THE ENGINEER.

MANUFACTURED ALTERNATIVES APPROVED AND LISTED ON THE DEPARTMENT'S EROSION CONTROL PRODUCT ACCEPTABILITY LIST MAY BE

WHEN REMOVING OR MAINTAINING INLET PROTECTION, CARE SHALL BE TAKEN SO THAT THE SEDIMENT TRAPPED ON THE GEOTEXTILE FABRIC DOES NOT FALL INTO THE INLET. ANY MATERIAL FALLING INTO THE INLET SHALL BE REMOVED IMMEDIATELY.

- 1 FINISHED SIZE, INCLUDING FLAP POCKETS WHERE REQUIRED, SHALL EXTEND A MINIMUM OF 10" AROUND THE PERIMETER TO FACILITATE MAINTENANCE OR REMOVAL.
- (2) FOR INLET PROTECTION, TYPE C (WITH CURB BOX), AN ADDITIONAL 18" OF FABRIC IS WRAPPED AROUND THE WOOD AND SECURED WITH STAPLES. THE WOOD SHALL NOT BLOCK THE ENTIRE HEIGHT OF THE CURB BOX OPENING.
- (3) FLAP POCKETS SHALL BE LARGE ENOUGH TO ACCEPT WOOD 2X4.

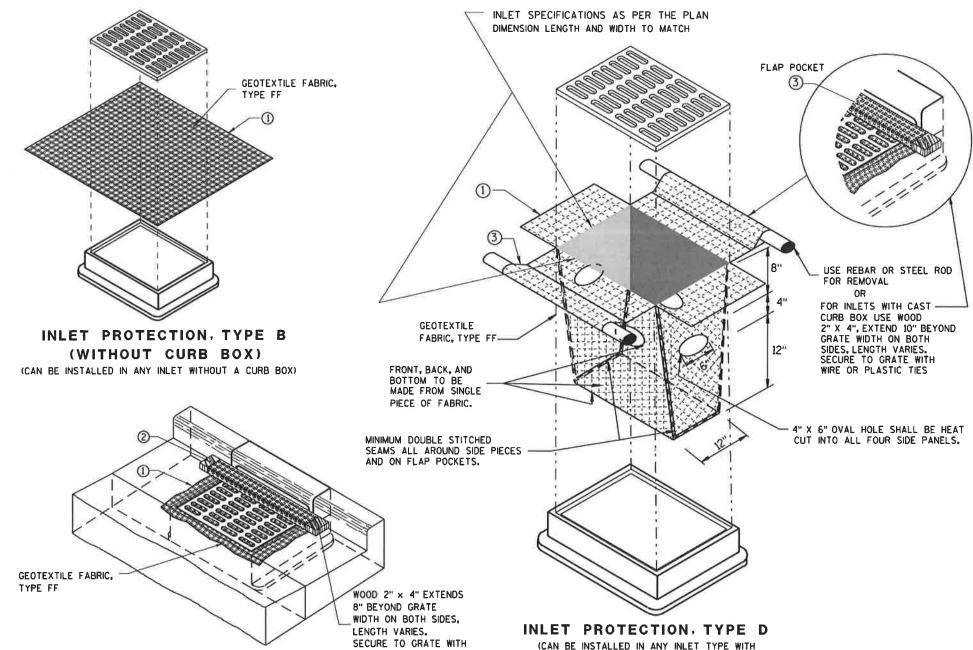

INLET PROTECTION, TYPE C (WITH CURB BOX)

INSTALLATION NOTES

TYPE B & C

TRIM EXCESS FABRIC IN THE FLOW LINE TO WITHIN 3" OF THE GRATE. THE CONTRACTOR SHALL DEMONSTRATE A METHOD OF MAINTENANCE, USING A SEWN FLAP, HAND HOLDS OR OTHER METHOD TO PREVENT ACCUMULATED SEDIMENT FROM ENTERING THE INLET.

WIRE OR PLASTIC TIES

TYPE D

DO NOT INSTALL INLET PROTECTION TYPE D IN INLETS SHALLOWER THAN 30", MEASURED FROM THE BOTTOM OF THE INLET TO THE TOP OF THE GRATE.

TRIM EXCESS FABRIC IN THE FLOW LINE TO WITHIN 3" OF THE GRATE.

THE INSTALLED BAG SHALL HAVE A MINIMUM SIDE CLEARANCE, BETWEEN THE INLET WALLS AND THE BAG. MEASURED AT THE BOTTOM OF THE OVERFLOW HOLES, OF 3". WHERE NECESSARY THE CONTRACTOR SHALL CINCH THE BAG, USING PLASTIC ZIP TIES, TO ACHIEVE THE 3" CLEARANCE. THE TIES SHALL BE PLACED AT A MAXIMUM OF 4" FROM THE BOTTOM OF THE BAG.

INLET PROTECTION TYPE A, B, C, AND D

STATE OF WISCONSIN DEPARTMENT OF TRANSPORTATION

APPROVED

/\$/ Beth Connestro DATE CHEF ROADWAY DEVELOPMENT ENGINEER

PROJECT NO:160530


CITY OF MILTON, WISCONSIN

COUNTY: ROCK

SHEET 8

BAXTER WOODMAN E

OR WITHOUT A CURB BOX AS PER NOTE (2)

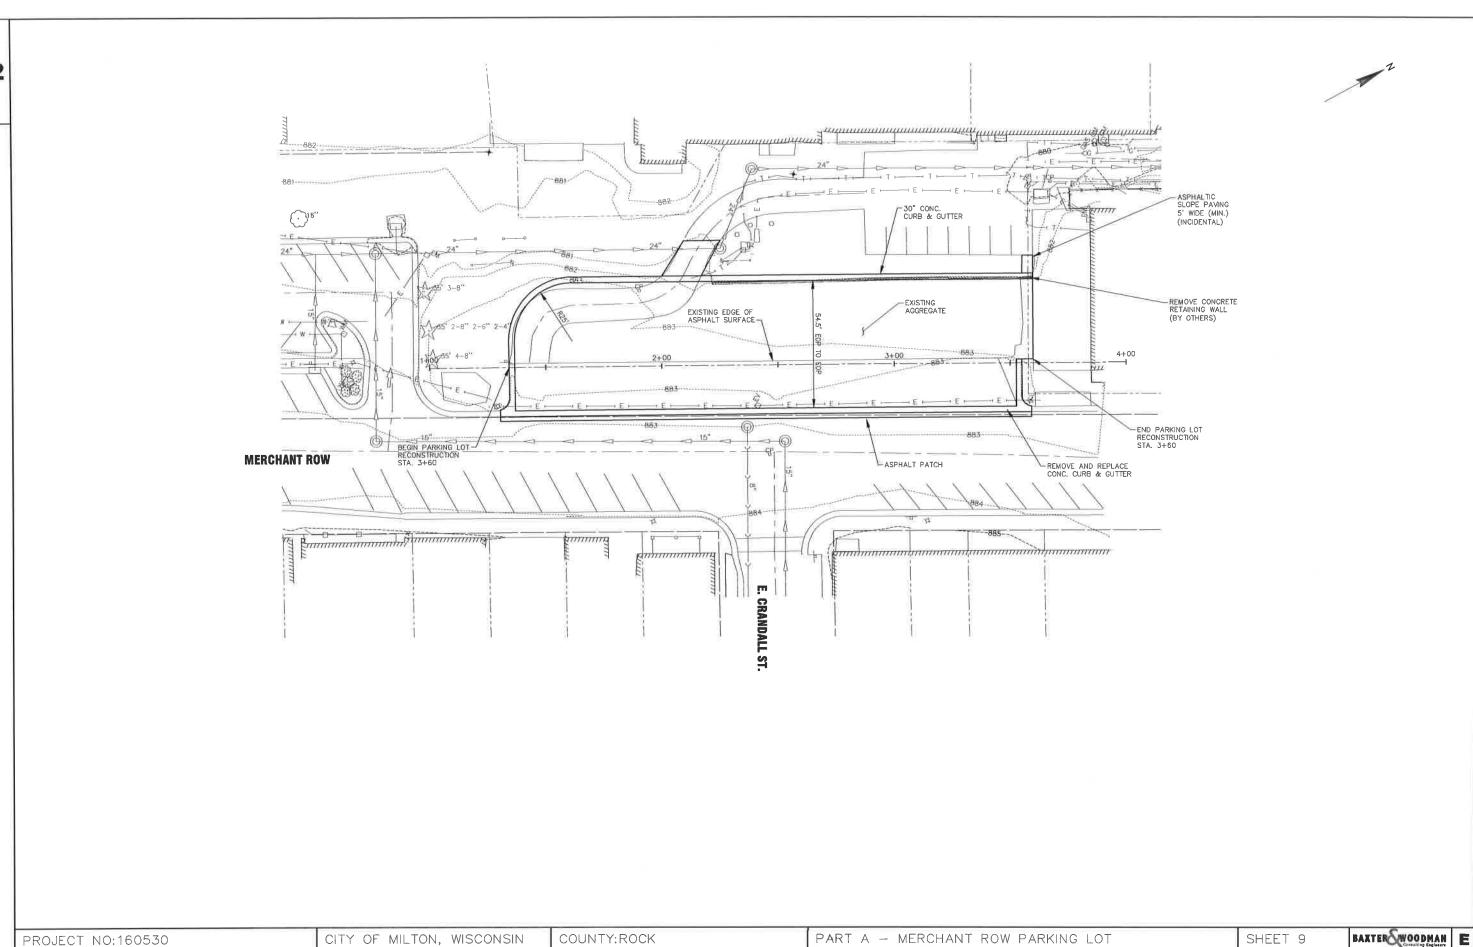


FILE NAME : 1:\BURLINGTON\MILTC\160530-MILTC - 2016 PAVEMENT IMP\CADD\DRAWINGS\DWG\40 - CURRENT\160530-APLN.DWG LAYOUT NAME - 160530-APLN - PLAN1

PLOT DATE : 6/28/2016 4:21 PM

PLOT BY : TIMOTHY L. BREY PLOT NAME :


BAXTER WOODMAN E

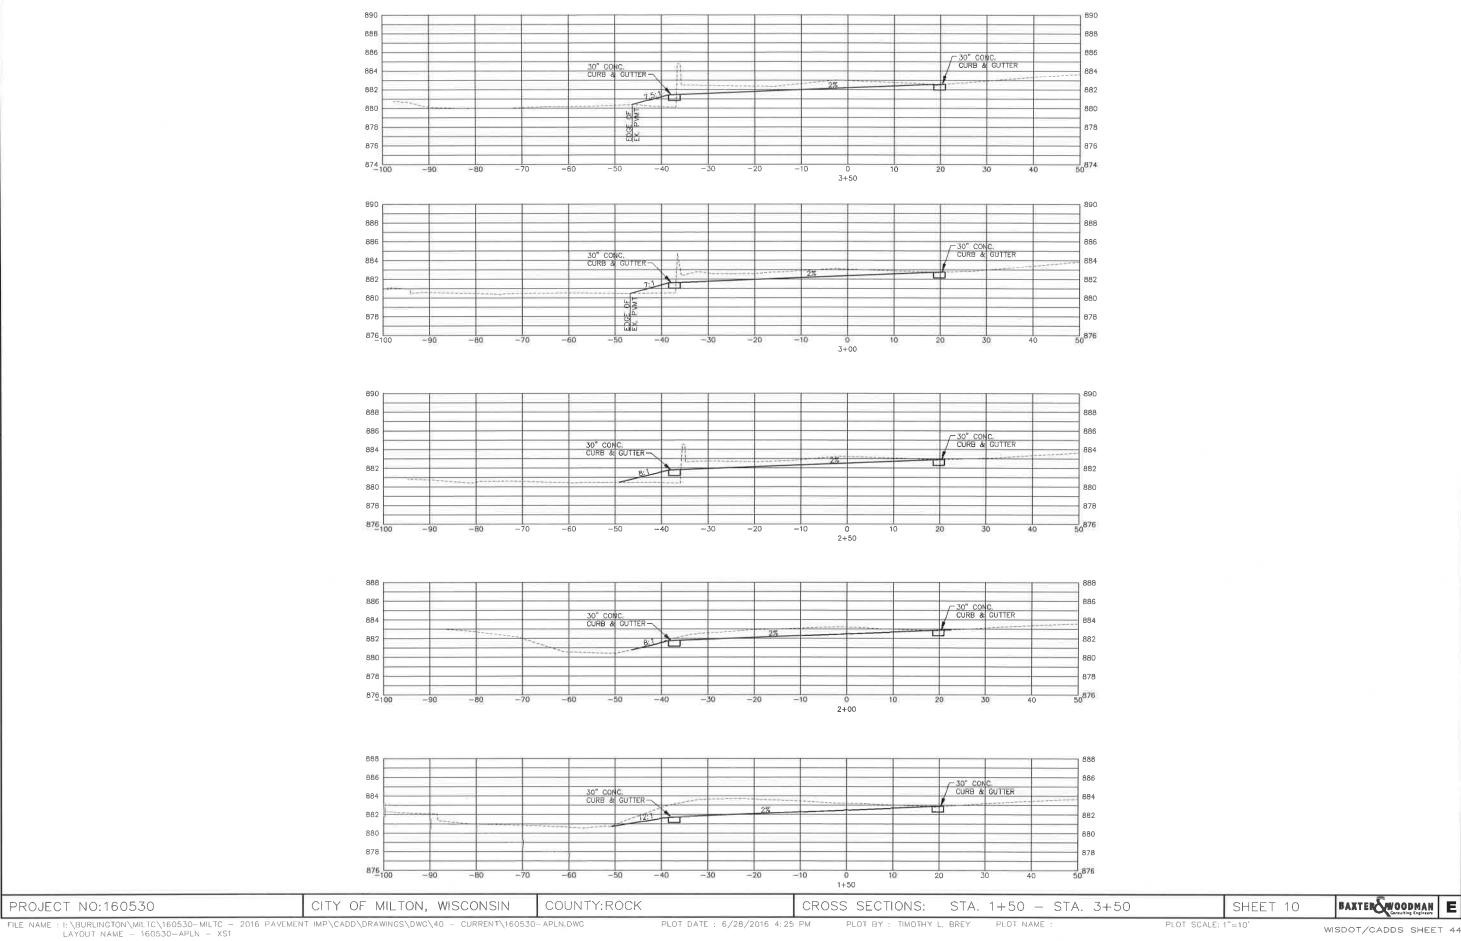

5





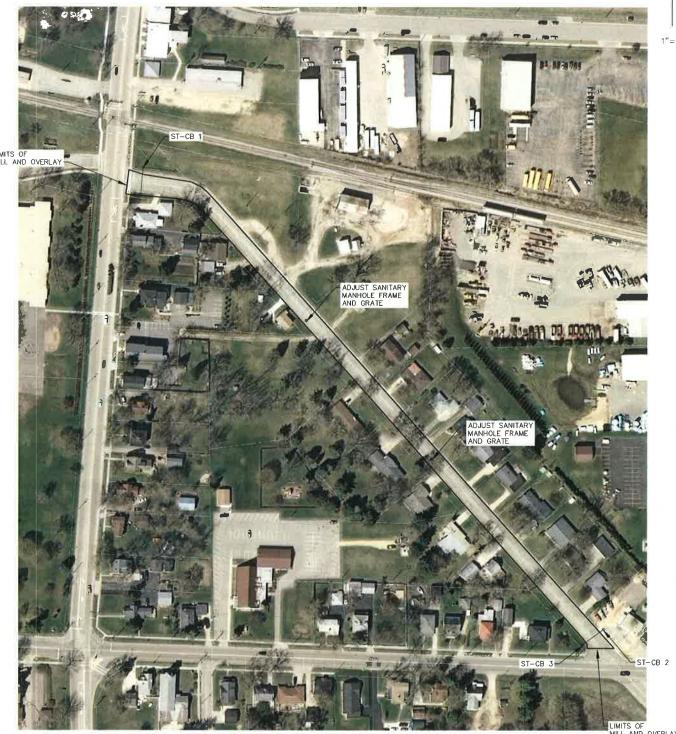

CATCH BASINS

ST-CB 1 ST-CB 2 ST-CB 3 2'X3' BOX 2'X3' BOX 2'X3' BOX 2'X3' BOX 1/C TO 12" I.E. S. = 31" T/C TO 12" I.E. S.W. = 38" T/C TO 12" I.E. S. = 52"

PROJECT NO:160530

10' (6" THICK HMA SURFACE)

CITY OF MILTON, WISCONSIN

COUNTY: ROCK

PLAN AND PROFILE: STA. 21+50 - STA. 25+95


SHEET 11

BAXTER WOODMAN E

O-INCH DOWELED

PART D - SERNS ROAD RESURFACING



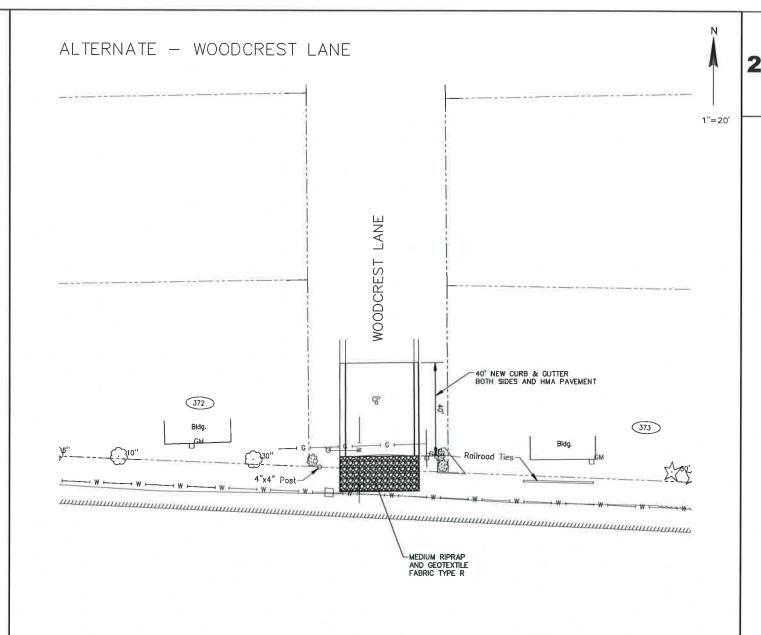

PROJECT NO:160530

CITY OF MILTON, WISCONSIN

COUNTY: ROCK

PLAN AND PROFILE: STA. 21+50 - STA. 25+95

SHEET 12

BAXTER WOODMAN E